ARCHITECTURAL KEYNOTES

KEYED NOTES BY DEFICIENCY

1- CORROSION

- $\langle 1A \rangle$ corrosion on door, replace in kind.
- $\langle 1B \rangle$ CORROSION ON DOOR FRAME, REPLACE. SEE DETAIL 1 ON DWG. G05N-A-502
- $\langle 1C \rangle$ CORROSION ON DOOR CLOSER. REPLACE IN KIND.
- 1D> CORROSION ON BOLLARD. SCRAPE CLEAN, PRIME, AND REPAINT TO MATCH EXISTING.
- 1E) CORROSION ON PIPE GUARD. SCRAPE CLEAN, PRIME, AND REPAINT TO MATCH EXISTING.
- $\langle 1 {
 m F}
 angle$ corrosion on handrail. Scrape clean, prime, and repaint to match existing.
- $\langle 1G \rangle$ corrosion on guardrail. Scrape clean, prime, and repaint to match existing.
- (1H) CORROSION ON FENCING/ LIGHTWALL FENCING. SCRAPE CLEAN, AND TREAT WITH ANTI-CORROSIVE.
- (11) CORROSION ON RAMP EDGE. SCRAPE CLEAN AND TREAT WITH ANTI-CORROSIVE
- $\overline{\left\langle 1\mathsf{J}\right\rangle}$ corrosion on sign post. Scrape clean, prime, and repaint to match existing.
- $\langle 1 \mathrm{K} \rangle$ corrosion on storefront mullions. Scrape clean and finish to match existing.
- $\langle 1_{\rm L} \rangle$ corrosion on gate booth. Scrape clean, prime, and repaint.
- $\langle 1M \rangle$ CORROSION ON FLASHING. REPLACE. SEE DETAIL 3 ON DWG. G05N-A-503.
- (1N) CORROSION ON CEILING TRIM. REPLACE IN KIND.

2 - IMPACT DAMAGE/ DISLODGED/ MISALIGNED

- $\overline{2A}$ MISALIGNED EXIT GATE. RESET.
- 2B DISLODGED/MISALIGNED SIGNPOST. REPLACE IN KIND. SEE DETAIL 4 ON DWG. G05N-A-502
- (2C) DAMAGED/ MISALIGNED DOOR. REPLACE IN KIND.
- $\langle 2D \rangle$ DAMAGED/ MISALIGNED DOOR CLOSER. REPLACE IN KIND.
- $\langle 2\mathsf{E}
 angle$ dislodged wheel stop. Reposition to proper location.
- $\langle 2F \rangle$ IMPACT DAMAGE TO FLASHING. REPLACE IN KIND. SEE DETAIL 3 ON DWG. G05N-A-502.
- $\langle 2G \rangle$ dislodged/ misaligned hanging sign. Replace in kind. See detail 1&2 on dwg. G05N-A-503.
- (2H) MISALIGNED THRESHOLD. REPLACE IN KIND. SEE SILL DETAIL 1&2 ON DWG. G05N-A-502.

3 - DETACHED/ DAMAGED

- 3A) DETACHED STOREFRONT MULLIONS. REATTACH.
- $\langle 3B \rangle$ DAMAGED CHAIN LINK FENCE. REPLACE IN KIND. SEE DETAIL 3 ON DWG. G05N-A-503.
- $\langle 3C \rangle$ DETACHED/MISSING TENSION BAR. REPLACE IN KIND. SEE DETAIL 2 ON DWG. G05N-A-503.
- $\overline{\langle 3D \rangle}$ DETACHED STAIR NOSING. REPLACE IN KIND. SEE STRUCTURAL DRAWING.

4 - CHIPPED/ PEELED PAINT ON ELEMENTS

- $\langle 4A \rangle$ CHIPPED/ PEELED PAINT ON BOLLARD. SCRAPE CLEAN, PRIME, REPAINT TO MATCH EXISTING.
- (4B) CHIPPED/ PEELED PAINT ON PIPE GUARD. SCRAPE CLEAN, PRIME, REPAINT REPAINT TO MATCH EXISTING.
- $\langle 4C \rangle$ CHIPPED/ PEELED PAINT ON HANDRAIL. SCRAPE CLEAN, PRIME, REPAINT REPAINT TO MATCH EXISTING.
- CHIPPED/ PEELED PAINT ON GUARDRAIL. SCRAPE CLEAN, PRIME, REPAINT REPAINT TO MATCH EXISTING.
- $\overline{\langle 4E \rangle}$ CHIPPED/ PEELED PAINT ON FIRE PROTECTION PIPE. SCRAPE CLEAN, PRIME, REPAINT REPAINT TO MATCH EXISTING.
- $\langle 4F \rangle$ CHIPPED/ PEELED PAINT ON WALLS. SCRAPE CLEAN, PRIME, REPAINT REPAINT TO MATCH EXISTING.
- \langle 4Gangle CHIPPED/ PEELED PAINT ON CLEARANCE BAR. SCRAPE CLEAN, PRIME, REPAINT REPAINT TO MATCH EXISTING.
- H) CHIPPED/ PEELED PAINT ON LIGHTWALL BAR. SCRAPE CLEAN, PRIME, REPAINT REPAINT TO MATCH EXISTING.

5 - FADED/ SCRATCHED PAINT ON SURFACES

- (5A) FADED OR MISSING PAVEMENT STOP BAR. (REPAINT ALL.) SEE DETAIL 1 ON DWG. A12-A-504.
- (5B) FADED OR DOUBLE ADA PAVEMENT MARKING. (REPAINT ALL.) SEE DETAIL 2 ON DWG. A12-A-504.
- $\langle 5C \rangle$ FADED OR DOUBLE PARKING STRIPE. REPAINT ALL. SEE DETAIL 3 ON DWG. A12-A-504.
- 5D) FADED NO PARKING STRIPING. REPAINT ALL TO MATCH EXISTING. 1
- 5E) FADED OR UNREADABLE SIGN. REPLACE IN KIND
- (5F) FADED OR MISSING PAVEMENT ARROWS. (REPAINT ALL.) SEE DETAIL 4 ON DWG. A12-A-504.
- (5G) FADED OR SCRATCHED CURB PAINT. REPAINT ALL TO MATCH EXISTING.
- (5H) FADED CROSSWALK. REPAINT ALL TO MATCH EXISTING.

6 - DAMAGED SEALANT

- (6A) DAMAGED SEALANT. SCRAPE CLEAN REPLACE IN KIND.
- (6B) DETACHED WEATHER STRIPPING. REINSTALL.

7 - MISSING ELEMENTS


- $\overline{\langle 7A \rangle}$ MISSING ACOUSTICAL CEILING TILES. REPLACE. SEE DETAIL 4 ON DWG. A12-A-503.
- 7B) MISSING SIGN. REPLACE IN KIND.
- $\langle 7 ext{C}
 angle$ missing/damaged hardware. Replace in kind. See door schedule, dwg. A12-A-501.
- $\langle ^{ extsf{7D}}
 angle$ missing screws/bolts. replace in kind.
- 7E〉 MISSING KICKPLATE. REPLACE IN KIND.
- (7F) MISSING OR DETACHED SAFETY STRIP. REPLACE IN KIND.
- $\overline{7}$ MISSING WALL TILES. REPLACE IN KIND.
- 7H \rangle MISSING TRAFFIC DELINEATOR. REPLACE IN KIND. SEE DETAIL 5 ON DWG. A12-A-503.

8 - STAINED/ VANDALIZED/ WORN OUT

- BA> STAINED/ VANDALIZED SIGN. POWERWASH.
- 8B> STAINED/ VANDALIZED WALL. POWERWASH.
- 8C> STAINED CEILING TILE. REPLACE IN KIND.
- 8D> STAINED OR WORN OUT FLOORING. REPLACE IN KIND.
- $\langle 8E \rangle$ STAINED/ VANDALIZED BOOTH. POWERWASH.
- (8F) STAINED/ VANDALIZED DOOR AND FRAME. POWERWASH AND REPAINT.

9 - MISCELLANEOUS

- $\langle 9A \rangle$ WASP OR BIRD NEST. REMOVE AS REQUIRED.
- (9B) PLANT ENCROACHMENT. REMOVE AS REQUIRED.

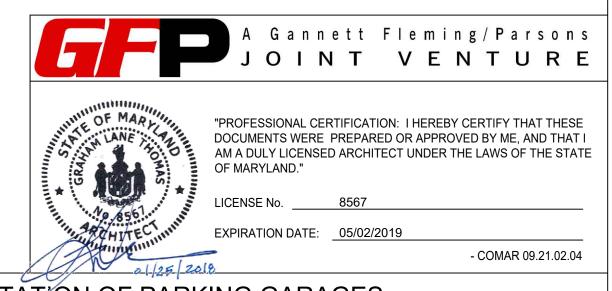

	REFERENCE DRAWINGS		REVISIONS		
DESIGNED A.KATIGBAK 01/2018	NUMBER	TITLE	DATE	NUM	DESCRIPTION
			01/25/2018	0	FINAL SUBMITTAL
DATE DRAWN A.KATIGBAK 01/2018			05/15/2018	1	AMENDMENT #2
DATE					
CHECKED G.THOMAS 01/2018					
DATE					

WASHINGTON METROPOLITAN AREA TRANSIT AUTHORITY


OFFICE OF DESIGN AND CONSTRUCTION IRPG - FIXED FACILITIES


APPROVED 01/25/2018 APPROVED 01/25/2018


JOHN PURDY DATE GRAHAM THOMAS DATE ARCHITECT OF RECORD

REHABILITATION OF PARKING GARAGES
G05 - LARGO TOWN CENTER - NORTH PARKING GARAGE
ARCHITECTURAL KEYNOTES BY DEFICIENCY


M NO.	CONTRACT NO.	SCALE	DRAWING NO.	SHEET NO.
M1301	FQ18064	N.T.S	G05N-A-002	225 of 503

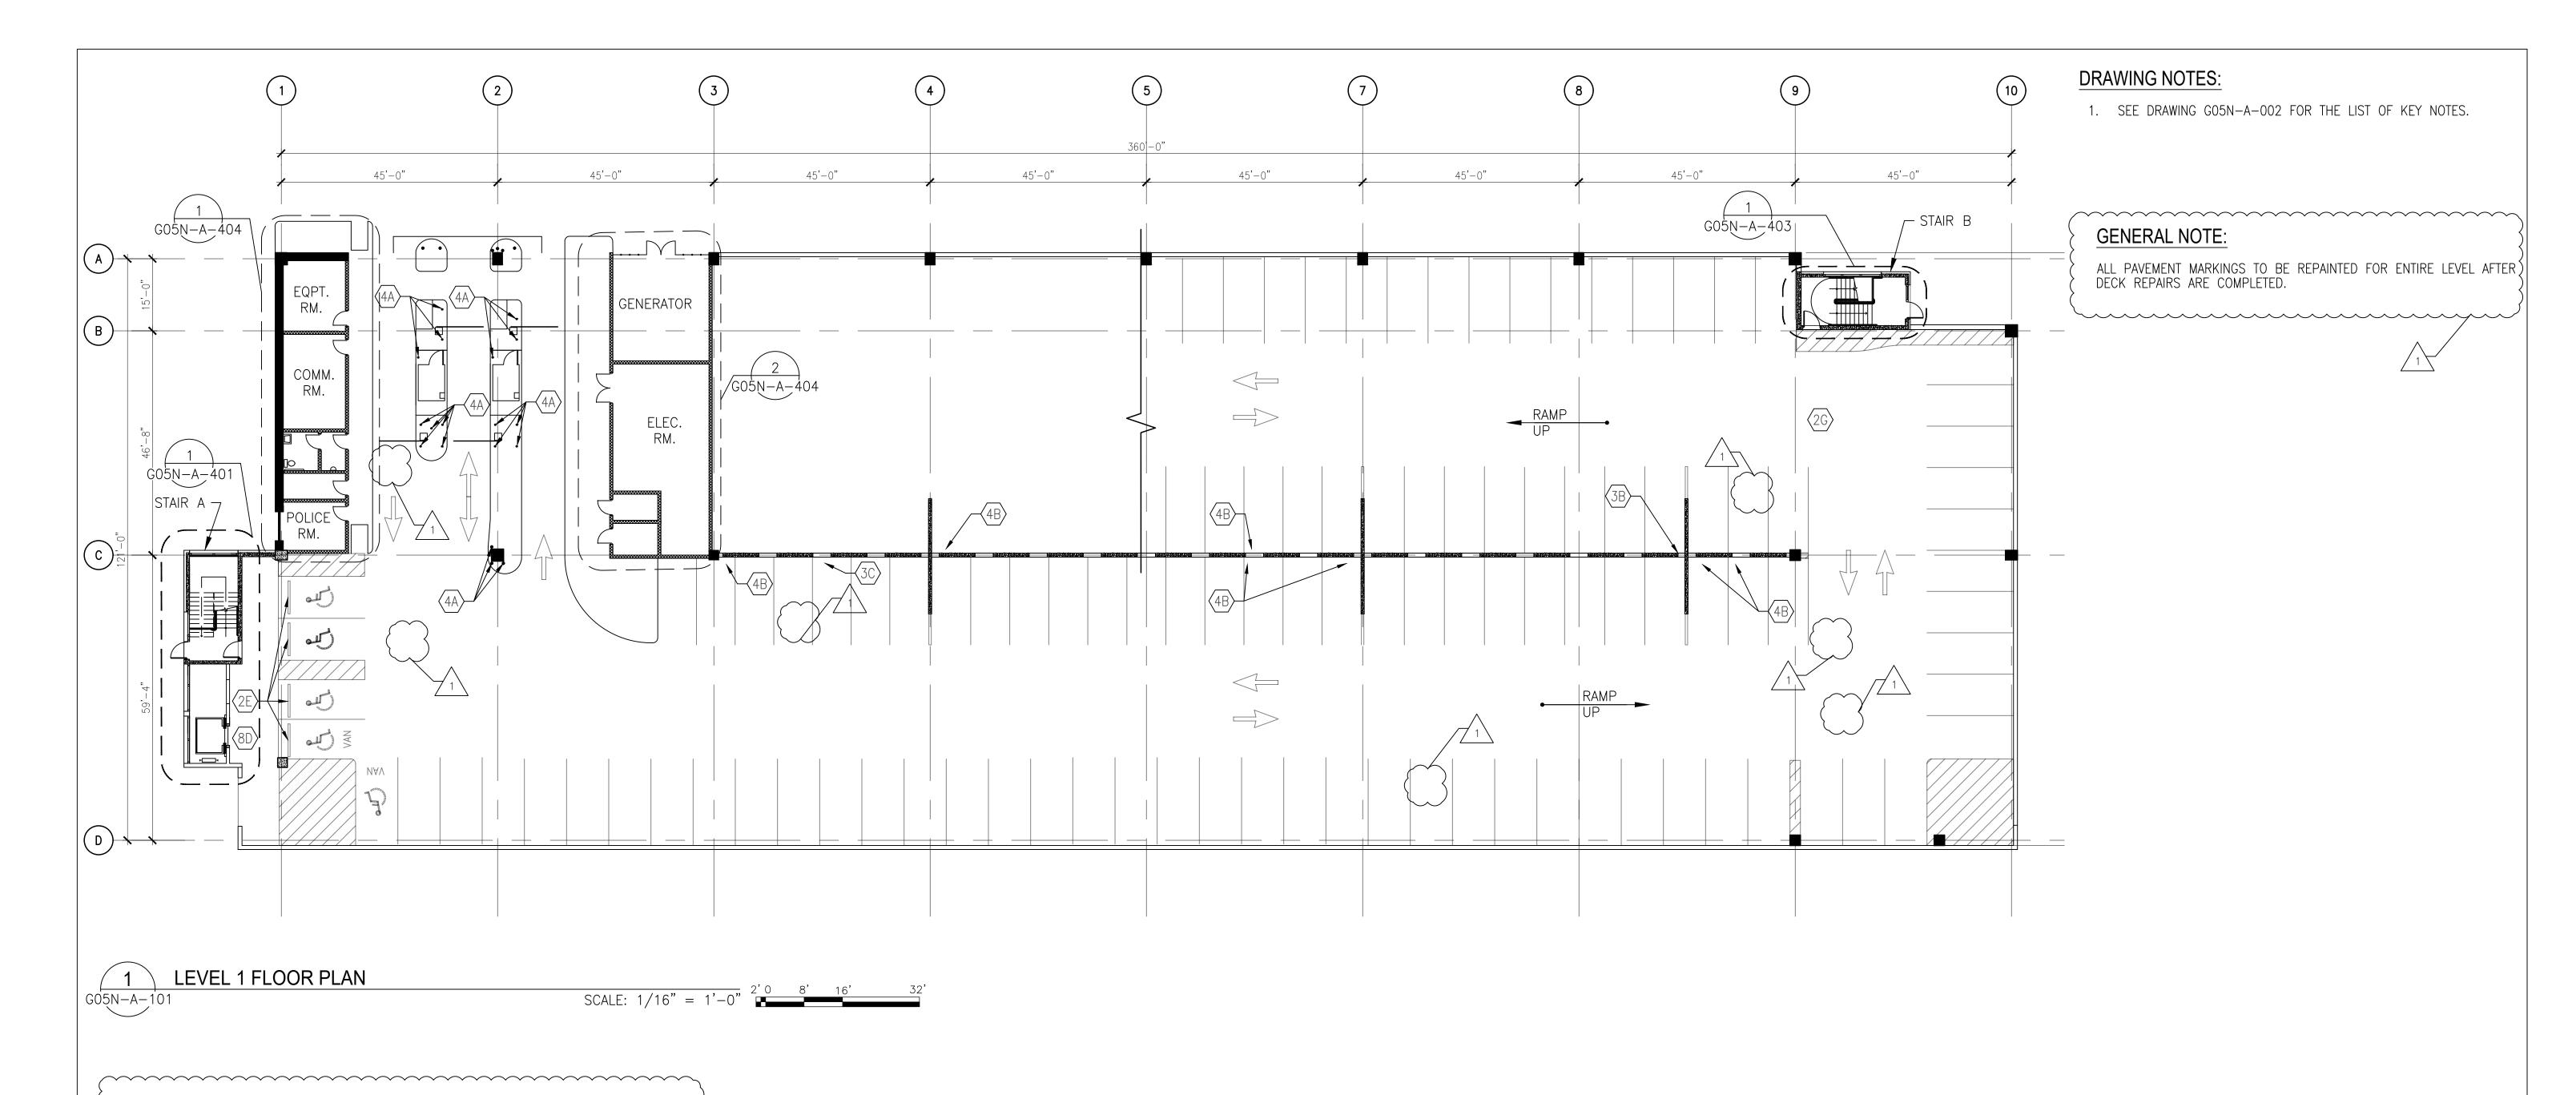

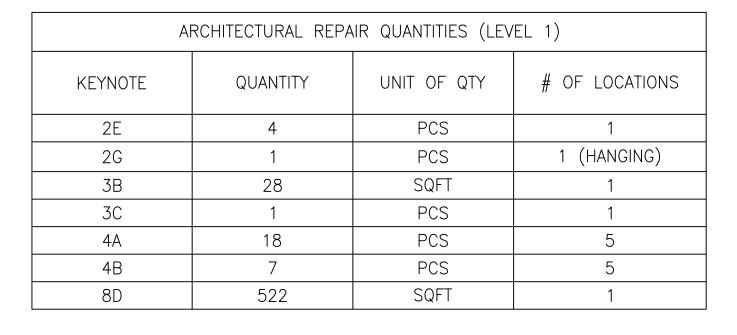

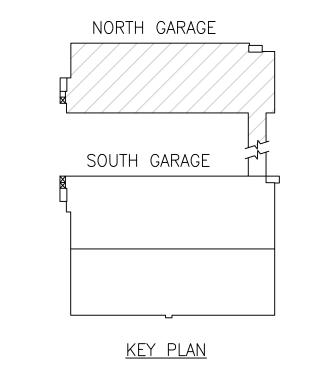

TRUE NORTH PLAN NORTH A Gannett Fleming/Parsons
JOINT VENTURE

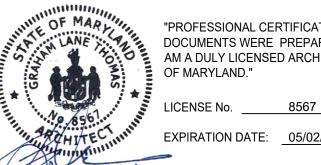

"PROFESSIONAL CERTIFICATION: I HEREBY CERTIFY THAT THESE DOCUMENTS WERE PREPARED OR APPROVED BY ME, AND THAT I AM A DULY LICENSED ARCHITECT UNDER THE LAWS OF THE STATE OF MARYLAND."

EXPIRATION DATE: 05/02/2019

- COMAR 09.21.02.04 REHABILITATION OF PARKING GARAGES G05 - LARGO TOWN CENTER - NORTH PARKING GARAGE

\\								
	~~~	~~~		REVISIONS				
}		)	NUMBER	TITLE	DATE	NUM	DESCRIPTION	metro
\	A.KATIGBAK	01/2018 DATE			01/25/2018	0	FINAL SUBMITTAL	
	A.KATIGBAK	01/2018			05/15/2018	1	AMENDMENT #2	
DRAWN <u>A</u>	· · · · · · · · · · · · · · · · · · ·	DATE						
CHECKED C	G.THOMAS	01/2018						
OHLONED _	-	DATE						APPROVED
					+			JOHN PURDY

WASHINGTON METROPOLITAN AREA TRANSIT AUTHORITY OFFICE OF DESIGN AND CONSTRUCTION

IRPG - FIXED FACILITIES APPROVED 01/25/2018

ENGINEERING MANAGER

DATE

APPROVED ( 01/25/2018 DATE GRAHAM THOMAS ARCHITECT OF RECORD

LEVEL 1 **FLOOR PLAN** CONTRACT NO. SCALE DRAWING NO. SHEET NO. FQ18064 1/16" = 1'-0" G05N-A-101 226 of 503

